

SITE PLAN - CRITICAL AREAS SCALE: 1" = 20'

CRITICAL AREAS INFORMATION

STEEP SLOPE 6495 SF **FULL AREA** 75' (TOE OF SLOPE) STRUCTURAL SETBACK

WETLAND CLASSIFICATION: CATEGORY III 4303 SF **FULL AREA** 2582 SF AREA W/O OVERLAP 8690 SF BUFFER AREA W/O OVERLAPS BUFFER 110' STRUCTURAL SETBACK 15'

STREAM CLASSIFICATION: TYPE F 1785 SF **FULL AREA** 1652 SF AREA W/O OVERLAP BUFFER AREA W/O OVERLAPS 5048 SF BUFFER 50' (DEVELOPED SITE) STRUCTURAL SETBACK 50' (DEVELOPED SITE) MIN. REQUIREMENT: 25' SETBACK

24,467 SF TOTAL CRITICAL AREA SQ FT:

THIS CRITICAL AREAS LAND USE PERMIT ADDRESSES REDUCING THE BUFFERS AND SETBACKS OUTLINED IN BELLEVUE LAND USE CODE SECTIONS LUC 20.25H.075(C) & (D) AND 20.25H.095(D) & (E).

CODE INFORMATION

ALL MATERIALS, WORKMANSHIP, DESIGN AND CONSTRUCTION SHALL CONFORM TO THE DRAWINGS, SPECIFICATIONS, AND THE FOLLOWING APPLICABLE CODES USED IN THIS DESIGN FOR CITY OF BELLEVUE

2015 INTERNATIONAL BUILDING CODE (IBC) 2015 INTERNATIONAL RESIDENTIAL CODE (IRC) 2015 INTERNATIONAL MECHANICAL CODE (IMC) 2015 INTERNATIONAL FUEL GAS COZDE (IFGC) 2015 INTERNATIONAL FIRE CODE (IFC) WASHINGTON STATE ENERGY CODE, WAC 51-11 (WSEC) 2015 UNIFORM PLUMBING CODE (UPC) 2014 NATIONAL ELECTRIC CODE (NEC) 2015 NATIONAL FUEL GAS CODE (NFGC) NFPA 54, WAC

ZONING & CODE INFORMATION

JURISDICTION: CITY OF BELLEVUE ZONING: R-3.5 USE: SINGLE FAMILY PARCEL ASSESSOR'S #: 925390-0430

LEGAL DESCRIPTION: WEOWNA BEACH UNREC & SH LDS ADJ LESS N 50 FT

OCCUPANCY: SINGLE FAMILY

SETBACKS REQUIRED: FRONT YARD - 20'-0" SIDE YARD - 5'-0"

> 2 SIDES = 15'-0" **REAR YARD - 25'-0"** SHORELINE SETBACK - 50'-0"

REAR YARD - 88'-0"

SETBACKS PROVIDED: FRONT - 250'-0" SIDE YARDS - 16'-5" & 5'-0"

PARKING REQUIRED: 2.0 PER DWELLING UNIT PARKING PROVIDED: 3.0 IN ATTACHED GARAGE

MAX BUILDING HEIGHT: 30' (FLAT) / 35' (PITCHED)


MAX LOT COVERAGE: 35% MAX HARD SURFACE: 75% 45% MAX IMPERVIOUS: MAX GREENSCAPE: 50% OF FRONT YARD


SHORELINE ENVIRONMENTS: 35' MAX BUILDING HEIGHT: 50% MAX IMPERVIOUS:

RELATED PERMITS

LAND USE VARIANCE: 20 114324 LS SHORELINE VARIANCE: TBD SHORELINE SUSTAINABLE DEVELOPMENT TBD TBD **BUILDING PERMIT:**



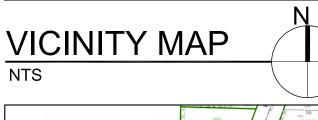

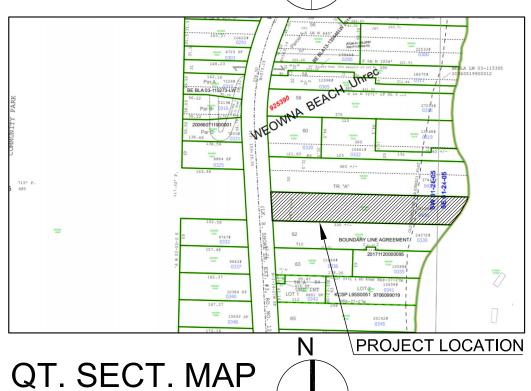

SITE PLAN NOTES

NTS

- 1. ALL PROPOSED UTILITIES TO TIE INTO EXISTING
- UTILITIES SHOWN ON PLAN. 2. FOR PROPOSED LANDSCAPING & CONSTRUCTION

MEASURES, REFER TO MITIGATION PLAN.

MEDICI ARCHITECTS

ARCHITECTURE I PROGRAMMING I ACCESSIBLE DESIGN I INTERIOR DESIGN www.mediciarchitects.com

11711 SE 8TH STREET, SUITE 100 BELLEVUE, WA 98005 TEL: (425) 453-9298

REGISTRATION:



INTAKE:	DATE:
REVISIONS:	DATE:
1.	
2.	
3.	
4.	
5.	

PROJECT / CLIENT:

FORTIN RESIDENCE

DAVE & LAUREL FORTIN 2004 W LAKE SAMMAMISH PKWY SE BELLEVUE, WA 98008

JOB ADDRESS:

2004 W LAKE SAMMAMISH PKWY SE BELLEVUE, WA 98008 PARCEL # 925390-0430

DRAWING NAME:

SITE PLAN B

Drawn By: JRG Checked By: ST Owner Approval:

PHASE:

SHORELINE DEVELOPMENT PERMIT

This drawing is the exclusive property of Medici Architects, and can be reproduced only with the permission of the Architect. Variations and modifications to work shown on this drawing shall not be carried out without written permission from the Architect.

APPROVED FOR CONSTRUCTION:

PROJECT No.: 2019 097 DATE: 01-03-21

PLOT SCALE: 1:1

A0.1



PROPOSED CONTOUR - EASEMENT LINE RETAINING WALL BM BENCH MARK SSMH SANITARY SEWER MANHOLE

S 88° 52' 32" E 296.84' BEARING

_____WATER SERVICE

_ CENTER LINE

GAS SERVICE

SANITARY SEWER

_ STORM DRAINAGE

BUILDING FOOTPRINT

_ EXISTING CONTOUR

· PROPERTY LINE

- SETBACK LINE

UNDERGROUND POWER


SYMBOL LEGEND:

BOW 386.0' BOTTOM OF WALL TREE TREE TO BE REMOVED POWER POLE WITH LIGHT CONCRETE STEEP SLOPE CRITICAL AREA WETLAND DELINEATION

FG 386.0' FINISHED GRADE

EG 386.0' EXISTING GRADE

TOW 386.0' TOP OF WALL

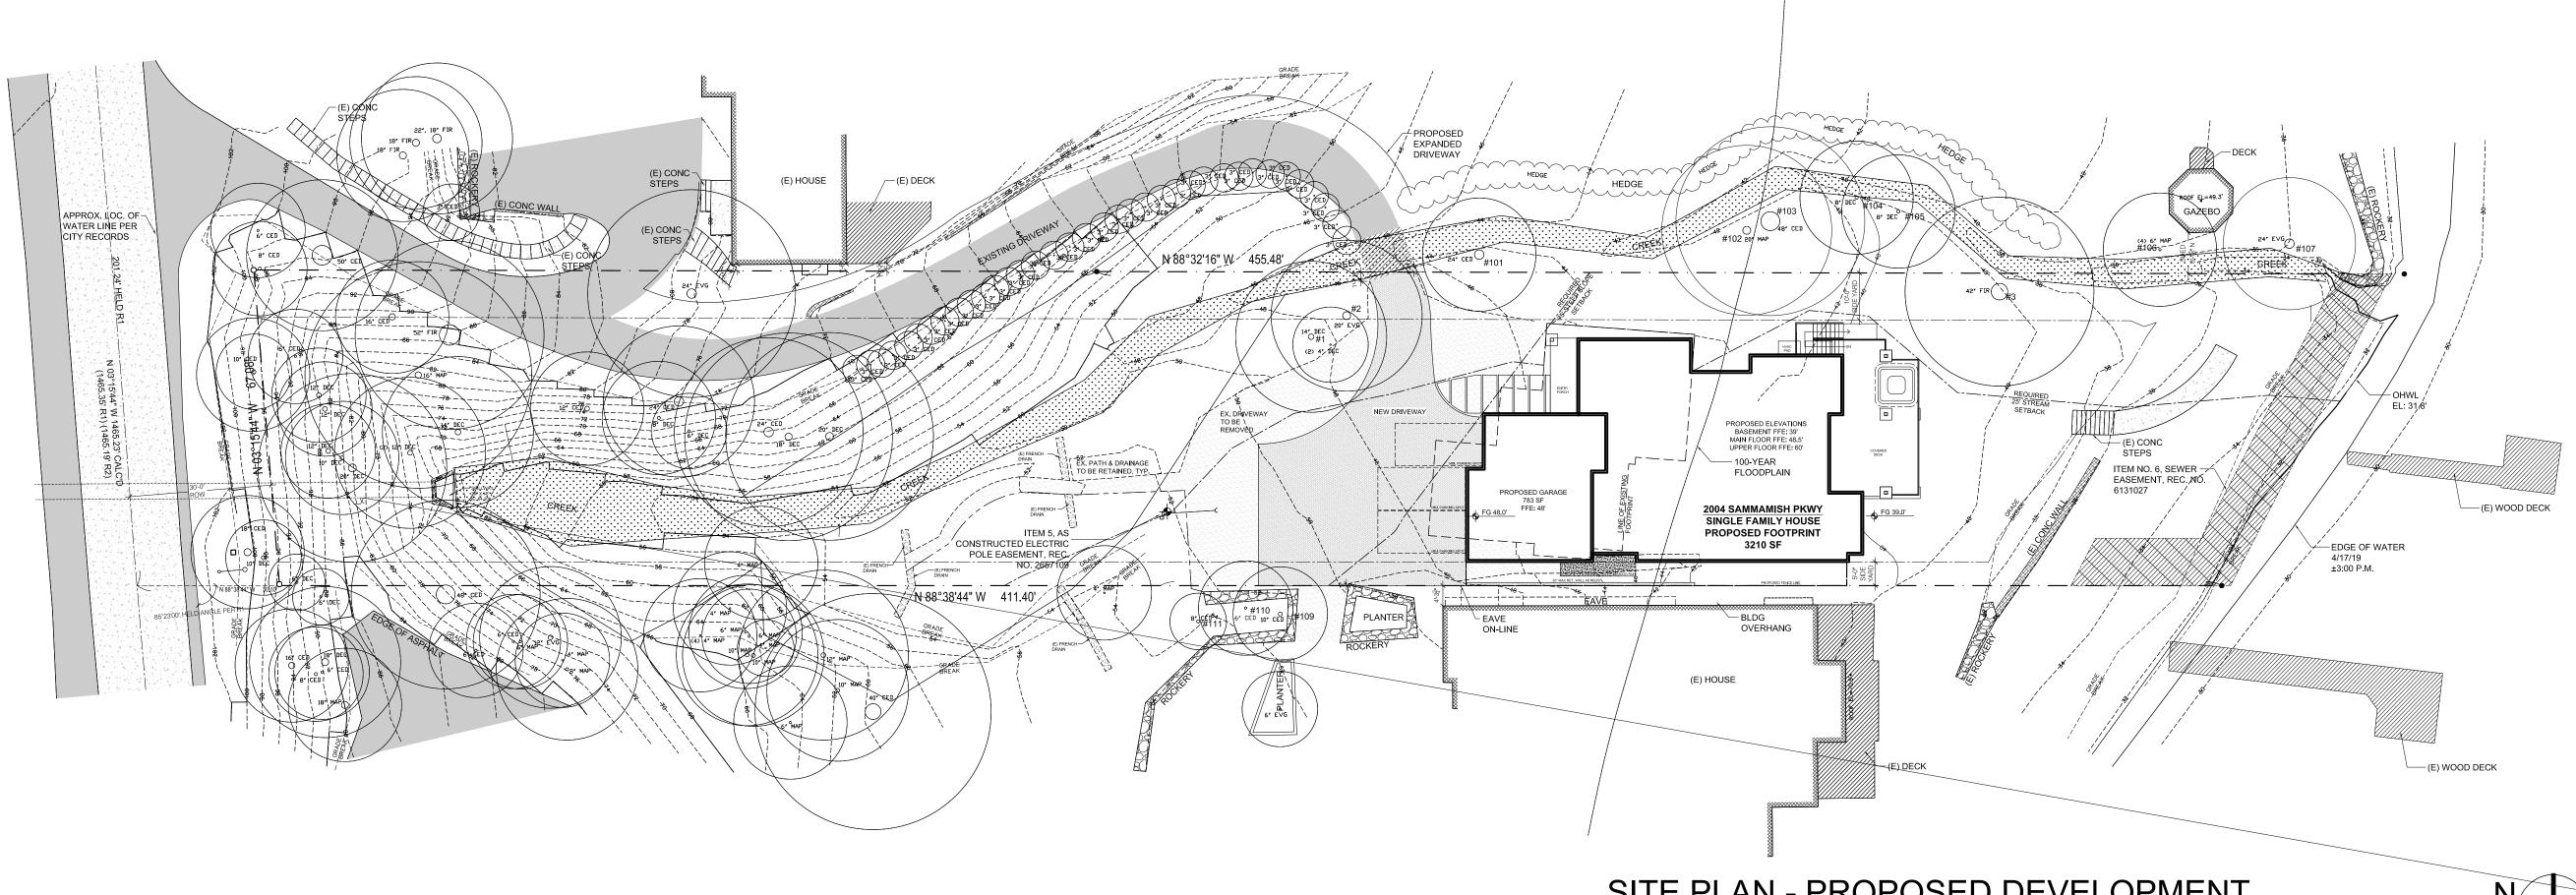

TREE PROTECTION GUIDELINES

All remaining trees are to have a tree protection zone (TPZ) established before commencement of any construction or delivery activities. The following guidelines are to be observed and practiced during all construction activities.

- Access is to be restricted into TPZ's with readily visible temporary tree fencing along the LOD which completely surrounds the protected areas of retained trees. Fences shall be constructed of chain link and be at least 4 ft tall, constructed using pier block, and major roots should be avoided while staking.
- Highly visible signs spaced no further than 15 feet shall be placed along sides of the TPZ fencing.
- Construction materials or supplies, soil, debris, vehicles, and equipment are not to be parked or stored within TPZ.
- TPZ fences must be inspected prior to the beginning of any construction activities.
- Assess crew and contractor penalties, if necessary, to keep the TPZ's intact.
- Check the integrity of TPZ fences weekly, and repair or replace as Wood chips should be used if possible to spread above root zones
- within the TPZ's to a depth of 6-8 inches for temporary protection. Cement trucks must not deposit waste or rinse out trucks in the TPZ.
- Avoid grade changes or trenching within or near the TPZ. If it is unavoidable, then follow the guidelines below.
- TPZ's may only be moved or accessed with permission from City Officials, and any work done within TPZ's must be done with a certified arborist present.
- If roots need to pruned, they should be cut with pruning saws, made flush with the side of the trench.
- Trees should be watered twice a week if construction is to take place during hot summer months.

If excavation occurs within the driplines of trees schedule	d for
retention, the following procedures must be followed to procedures must be followed to procedure	otect
them:	

- The contractor shall verify the vertical and horizontal location of existing utilities to avoid conflicts and maintain minimum clearances;
- adjustment shall be made to the grade of the new utility as required. • The inner root zone shall not be disturbed or cut (inner root zone = half the drip line radius).
- trenching/ excavation. The Arborist should have a shovel, hand pruners, loppers, handsaw, and a sawsall.
- If roots one inch or larger are damaged by equipment, the Arborist shall stop the equipment and have the dirt excavated by hand until the root can be cleanly cut. A clean straight cut shall be made to remove the damaged portion of root, and if possible the roots should be covered in moist burlap until recovered with dirt the same day.
- alternative to trenching through roots. It shall be performed under the supervision of an ISA Certified Arborist, and no roots 1 inch in diameter or larger shall be cut.
- zone of trees to be preserved without the Planning Official's authorization based on recommendations from a qualified professional. The Planning Official may allow coverage of up to one half of the area of the tree's critical root zone with light soils (no clay) to the minimum depth necessary to carry out grading or landscaping plans, if it will not imperil the survival of the tree. Aeration devices may be required to ensure the tree's survival.

	EXISTING TREE CLASSIFICATIONS		
Tag #	Species		DBH
1	Magnolia	TO SAVE	15
2	Norway Spruce	TO SAVE	21
3	Douglas Fir	TO SAVE	37
		Total:	73
	NEIGHBORING	S/OFF-SITE TREES	
101	Western Red Cedar	PROTECT	24
102	Bigleaf maple	PROTECT	19
103	Western Red Cedar	PROTECT	46
104	Oregon Ash	PROTECT	8
105	Oregon Ash	PROTECT	10
106	Japenese Maple	PROTECT	13
107	White Spruce	PROTECT	28
108	Western Red Cedar	PROTECT	12
109	Western Red Cedar	PROTECT	10
110	Western Red Cedar	PROTECT	8
111	Western Red Cedar	PROTECT	9

ISA Certified arborist must work with equipment operators during

- Boring or tunneling under roots of existing trees is a viable
- The grade shall not be elevated or reduced within the critical root

SYMBOL LEGEND:

	CENTER LINE
	SANITARY SEWER
	STORM DRAINAGE
	UNDERGROUND POWER
	WATER SERVICE
	— LINE OF ROOF ABOVE
	— BUILDING FOOTPRINT
· ·	— PROPERTY LINE
	— SETBACK LINE
	_ EXISTING CONTOUR
	PROPOSED CONTOUR
	EASEMENT LINE
	∽ FENCE
	RETAINING WALL
ВМ	I BENCH MARK
SSMH	SANITARY SEWER MANHOLE
S 88° 52' 32" E 296.84'	BEARING

FG 386.0'	FINISHED GRADE
EG 386.0'	EXISTING GRADE
TOW 386.0'	TOP OF WALL
BOW 386.0'	BOTTOM OF WALL
0	TREE
X	TREE TO BE REMOVED
\$	POWER POLE WITH LIGHT
	CONCRETE
	STEEP SLOPE CRITICAL AREA
· · · · · ·	CREEK
+ + -	WETLAND DELINEATION
	BUFFER AREA FOR LOT
	COVERAGE CALCULATION

SITE PLAN - PROPOSED DEVELOPMENT SCALE: 1" = 20'

LOT CALCULATIONS

LOT SIZE:	29,129 SF
CRITICAL AREAS & BUFFERS:	24,467 SF
AREA FOR LOT COVERAGE CALCULATION:	4,662 SF
LOT COVERAGE % ZONE R3.5 35%:	1,631.7 SF
EXISTING CONC STAIRS:	200 SF
PROPOSED HOUSE FOOTPRINT:	3210 SF

PROPOSED EXTERIOR DECK & STAIRS: 590 SF 4,000 SF (86%) TOTAL SF:

VARIANCE REQUEST: EXCEED LOT COVERAGE OF 35% PER LUC 20.20.010 BY MEETING REQUIREMENTS ON LUC 20.30G.

IMPERVIOUS SURFACE % ZONE R3.5 45%: 13.108.1 SF **EXISTING CONC STAIRS:** 200 SF **EXISTING CONC WALL:** 48 SF 208 SF EXISTING GRAVEL PATH: 1308 SF **EXISTING DRIVE:** 430 SF PROPOSED DRIVE EXPANSION: PROPOSED HOUSE FOOTPRINT: 3210 SF 250 SF PROPOSED FRONT WALKWAY: 590 SF PROPOSED EXTERIOR DECK & STAIRS: 72 SF PROPOSED CONC PATIO: PROPOSED CONC RETAINING WALL: 32 SF 1978 SF PROPOSED DRIVEWAY: **TOTAL SF:** 8326 SF (29%)

FRONT YARD GREENSCAPE % ZONE R3.5 50% FRONT YARD: 1341 SF

670.5 SF 50%:

HARDSCAPE MATERIALS: 0 SF **TOTAL GREENSCAPE SF:** 1341 SF (100%)

TOTAL BLDG:

FLOOR AREA RATIO

	LOT SIZE: MAX F.A.R. 50% =	29,129 SF 14,564.5 SF
	LOWER FLOOR LIVING: MAIN FLOOR LIVING: UPPER FLOOR LIVING:	344 SF 2278 SF 2341 SF
	TOTAL LIVING:	4,963 SF
)	GARAGE:	788 SF

5751 SF (20%)

MEDICI ARCHITECTS

ARCHITECTURE I PROGRAMMING I ACCESSIBLE DESIGN I INTERIOR DESIGN www.mediciarchitects.com

11711 SE 8TH STREET, SUITE 100 BELLEVUE, WA 98005 TEL: (425) 453-9298

REGISTRATION:



INTAKE:	DATE:
REVISIONS:	DATE:
1.	
2.	
3.	
4.	
5.	

PROJECT / CLIENT:

FORTIN RESIDENCE

DAVE & LAUREL FORTIN 2004 W LAKE SAMMAMISH PKWY SE BELLEVUE, WA 98008

JOB ADDRESS:

2004 W LAKE SAMMAMISH PKWY SE BELLEVUE, WA 98008 PARCEL # 925390-0430

DRAWING NAME:

SITE PLAN B

Drawn By: JRG Checked By: ST Owner Approval:

PHASE:

SHORELINE DEVELOPMENT PERMIT

This drawing is the exclusive property of Medici Architects, and can be reproduced only with the permission of the Architect. Variations and modifications to work shown on this drawing shall not be carried out without written permission from the Architect.

APPROVED FOR CONSTRUCTION:

PROJECT No.: 2019 097 DATE: 01-03-21

PLOT SCALE: 1:1